

VILLAGE OF DANNEMORA

# LaFontaine Recreational Park Project


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Proposed Site Plan

Zachary Babbie

6/26/2012



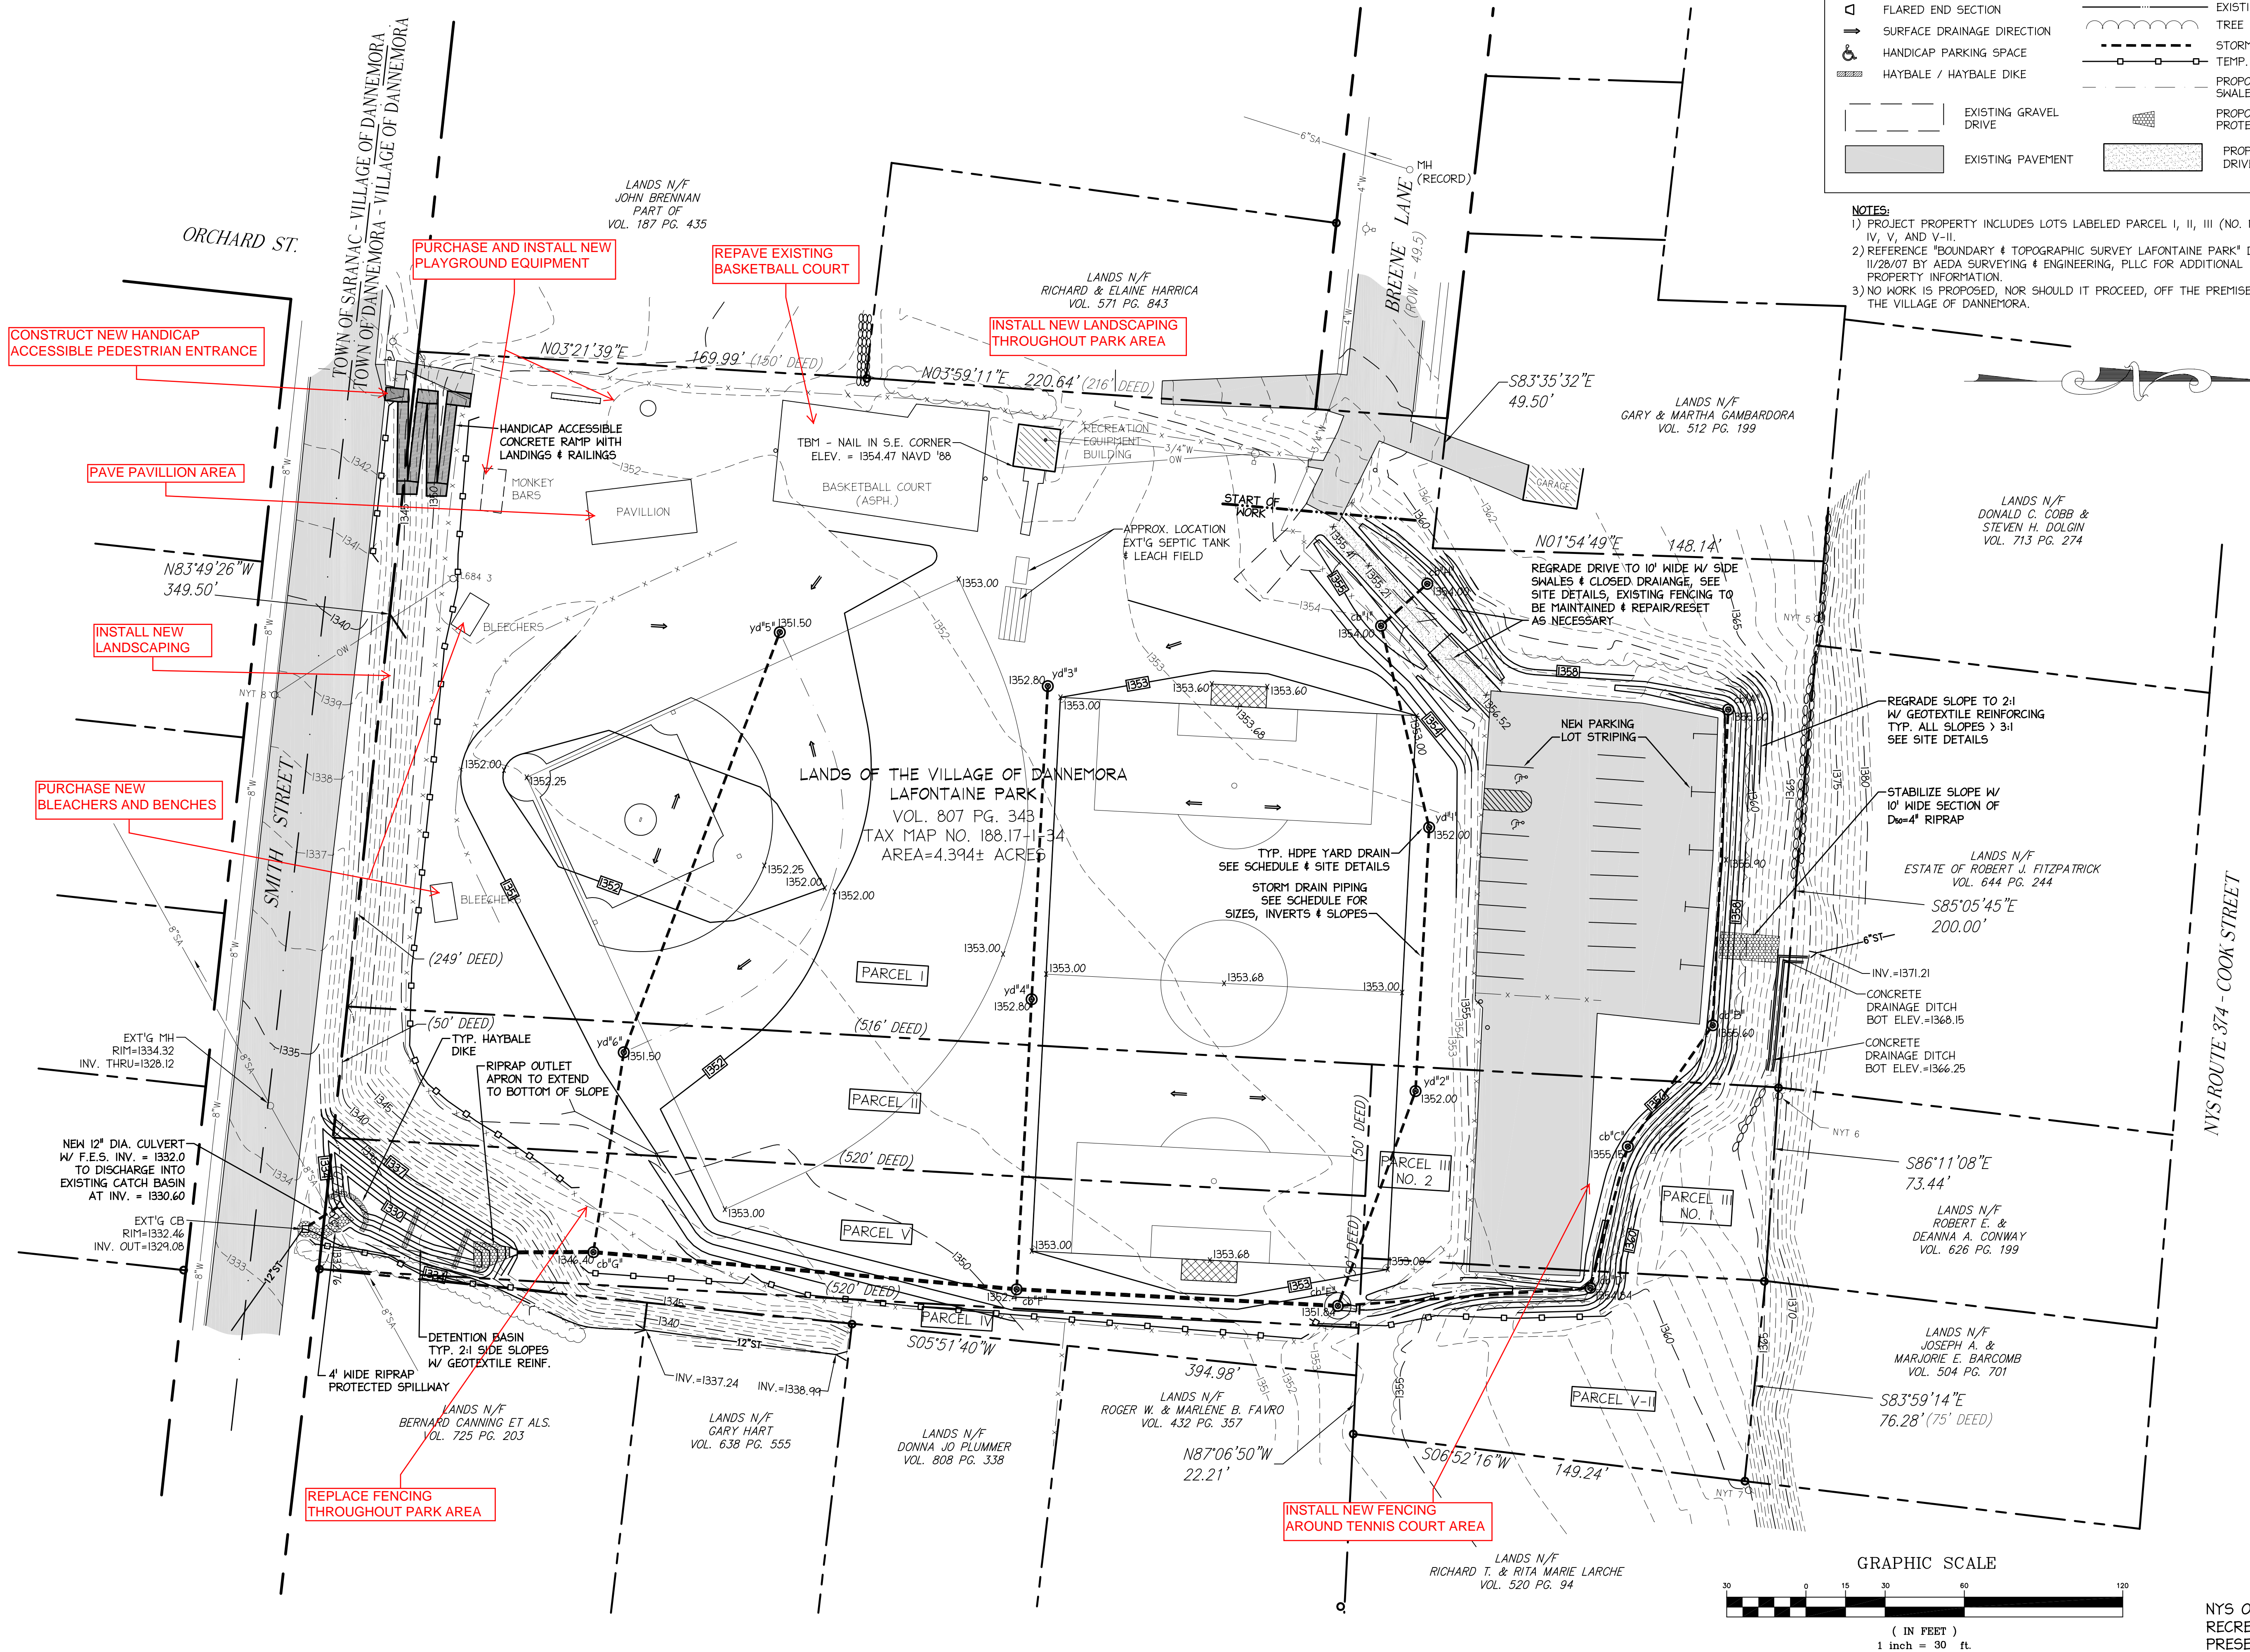

Established in 1985

AEDA

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PROJECT TITLE

VILLAGE OF DANNEMORA  
LAFONTAINE PARK  
IMPROVEMENTS

BRENE LANE, VILLAGE OF DANNEMORA, CLINTON COUNTY, NEW YORK

ENGINEER STAMP

REVISIONS

1	MSC	7/15/08
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DRAWING TITLE

SITE PLAN

DRAWN BY

MSC

CHECKED BY

JAA

DATE

3/3/08

PROJECT NO.

07106

C1.1

NYS OFFICE OF PARKS,  
RECREATION & HISTORIC  
PRESERVATION  
PROJECT # EPF-540530



RICHARD ST.

TOWN OF SARANAC - VIL  
TOWN OF DANNEMORA - V

Construct a New Handicap Accessible  
Entrance (As Illustrated Here)

N03°21'39"E

169.99' (150' DEE

HANDICAP ACCESSIBLE  
CONCRETE RAMP WITH  
LANDINGS & RAILINGS

MONKEY  
BARS

PAVILLION

N83°49'26"W  
349.50'


8"W

OL684 3

BLEACHERS


yd



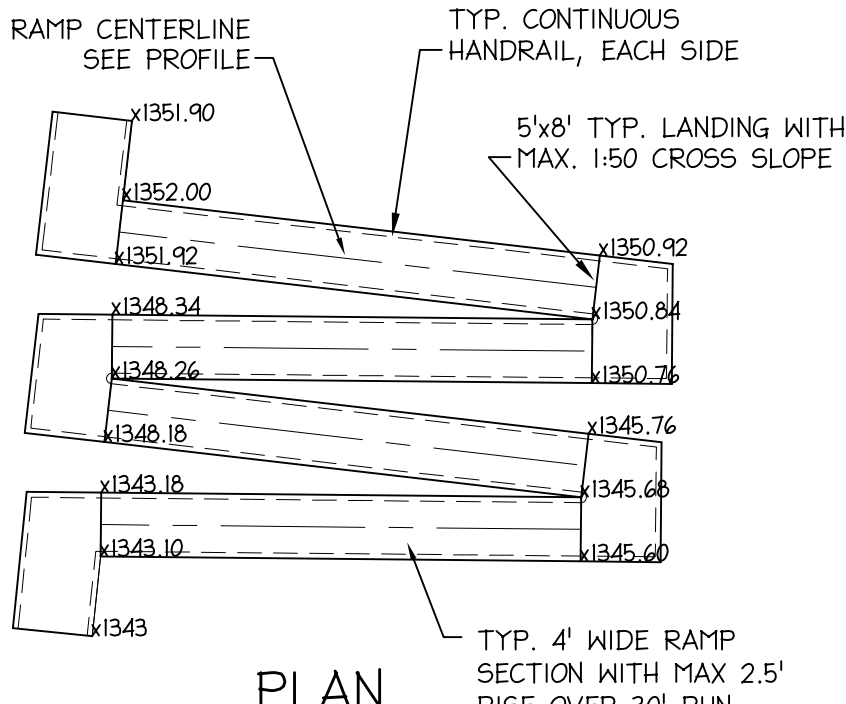


HANDICAP RAMP SECTION  
N.T.S.


- NOTE:
- COORD. & VERIFY ALL RAMP GRADES W/ ENGINEER PRIOR TO INSTALLATION.
  - PROVIDE TYP. TOOLED FINISH AT SIDEWALK EDGES.
  - PROVIDE TYP. TOOLED/TROWELED CONTROL JOINT AT 5'-0" SPACING.
  - PROVIDE BREAK IN POUR/EXPANSION JOINT W/ 1/4" MIN. THICKNESS PREMOLDED FILLER EVERY 20'-0".
  - PROVIDE LT. BROOM FINISH PERPENDICULAR TO SIDEWALK.

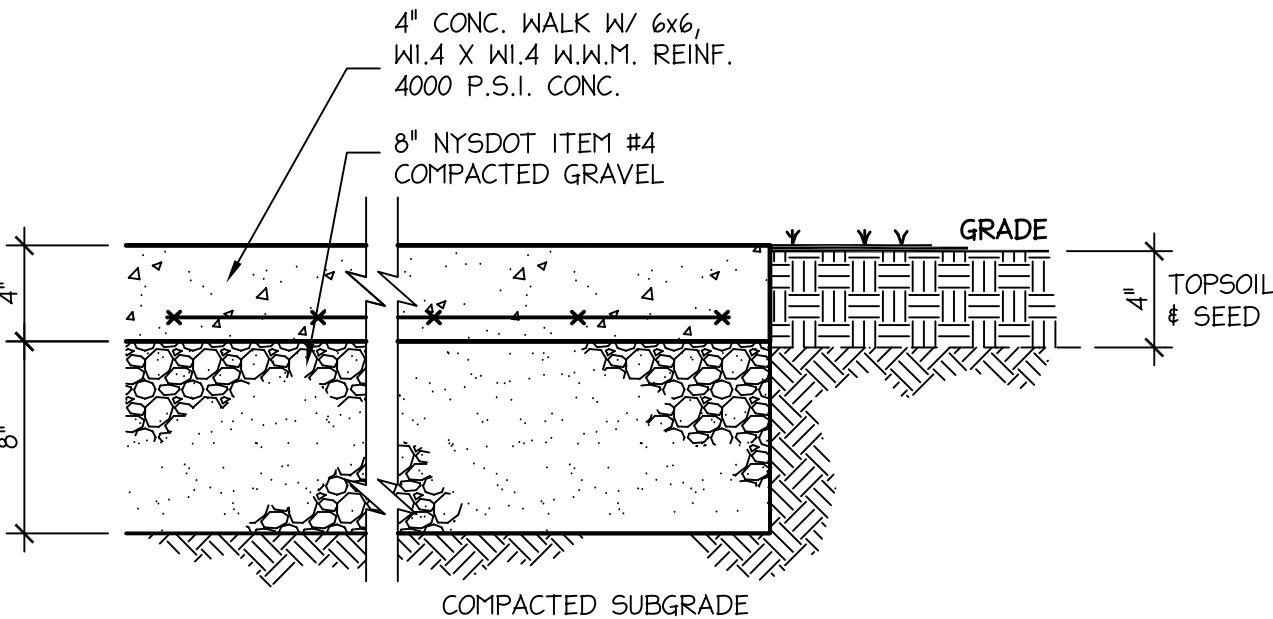


TYP. CONC. WALK DETAIL  
SCALE: 1-1/2" = 1'-0"

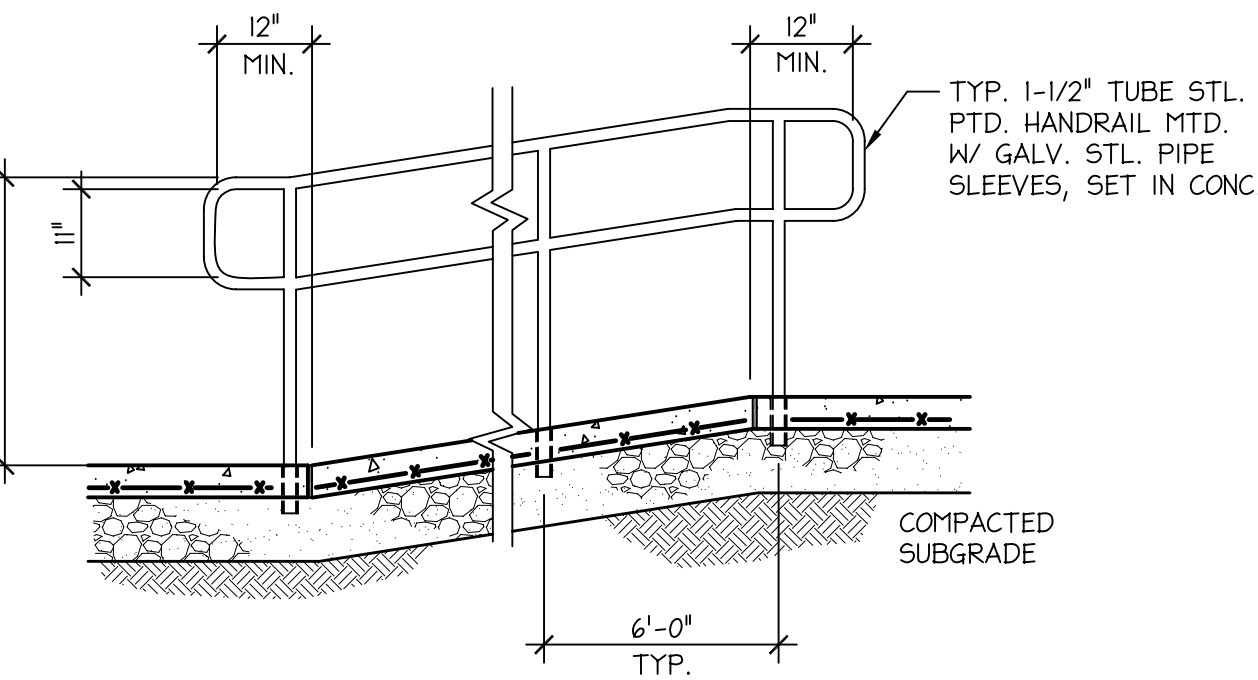


TYP. RAMP RAILING ASSEMBLY  
N.T.S.

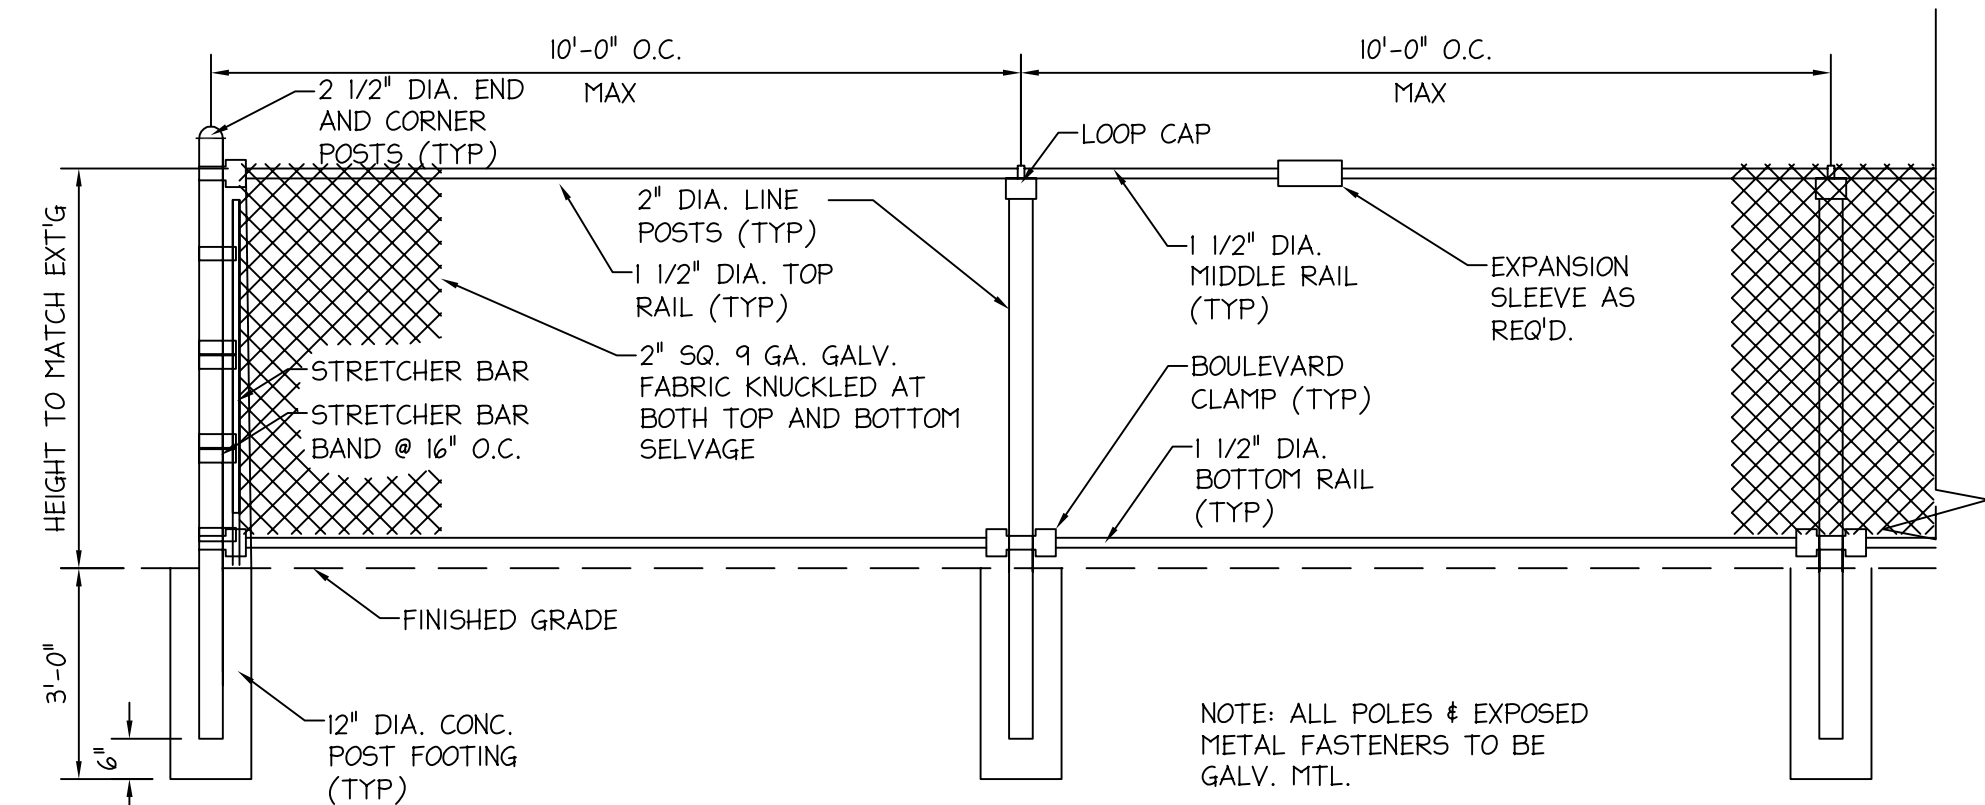

TYP. CHAIN LINK FENCE DETAIL  
N.T.S.

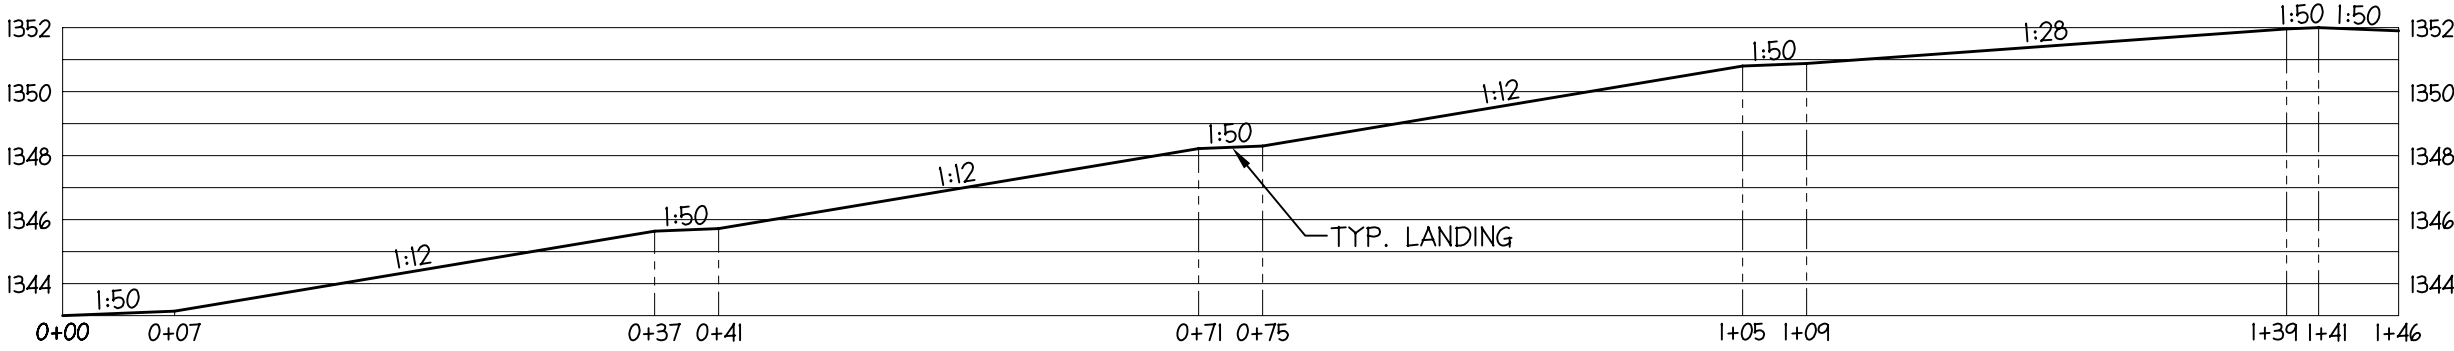


GRAVEL DRIVE SECTION  
N.T.S.

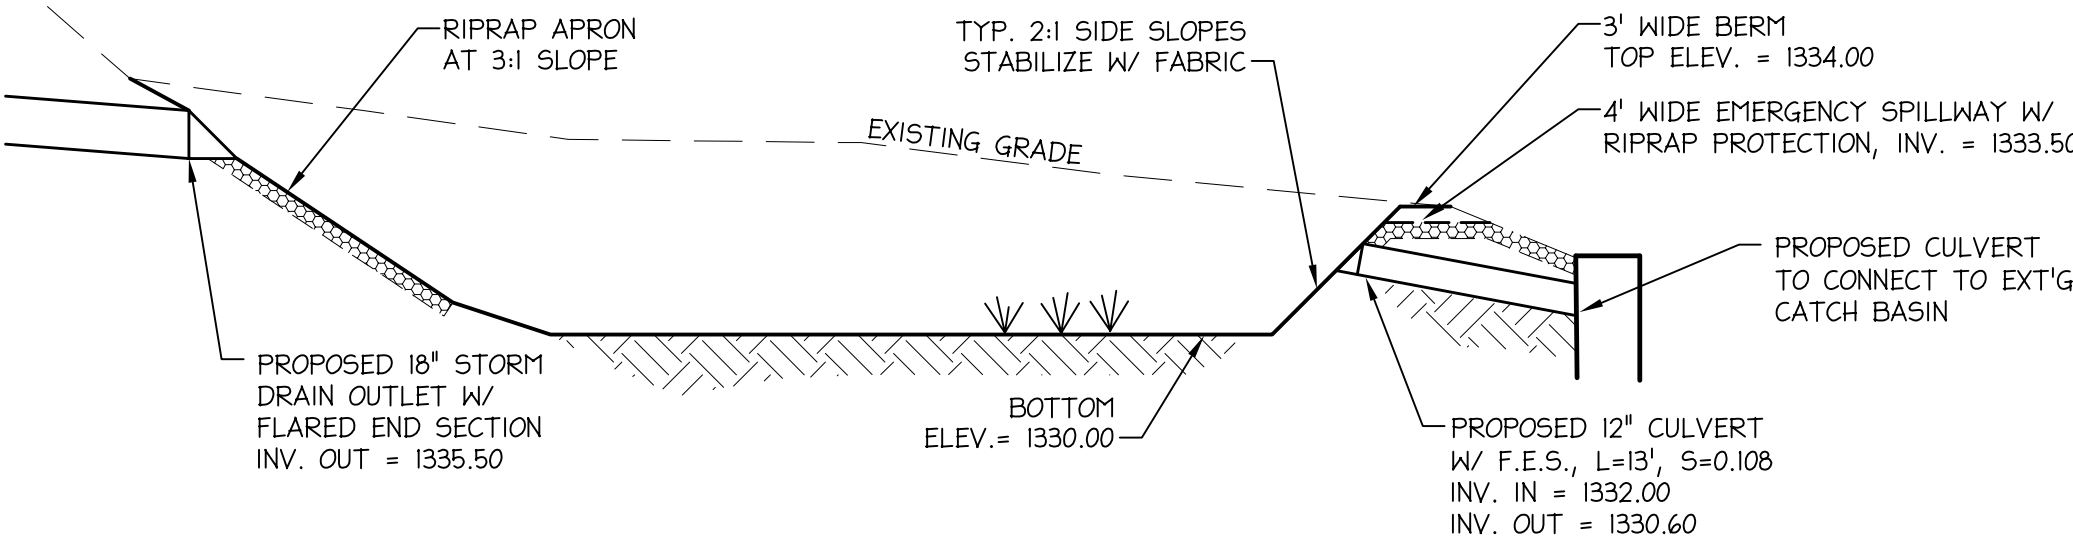


DETENTION BASIN CROSS SECTION  
N.T.S.

RIPRAP APRON SCHEDULE				
PIPE DIA.	RIPRAP dia	LENGTH	WIDTH	DEPTH
18"	4"	10 FT*	12 FT	9 IN.


\*- EXTEND LENGTH AS NECESSARY TO OUTLET TO RELATIVELY FLAT TERRAIN

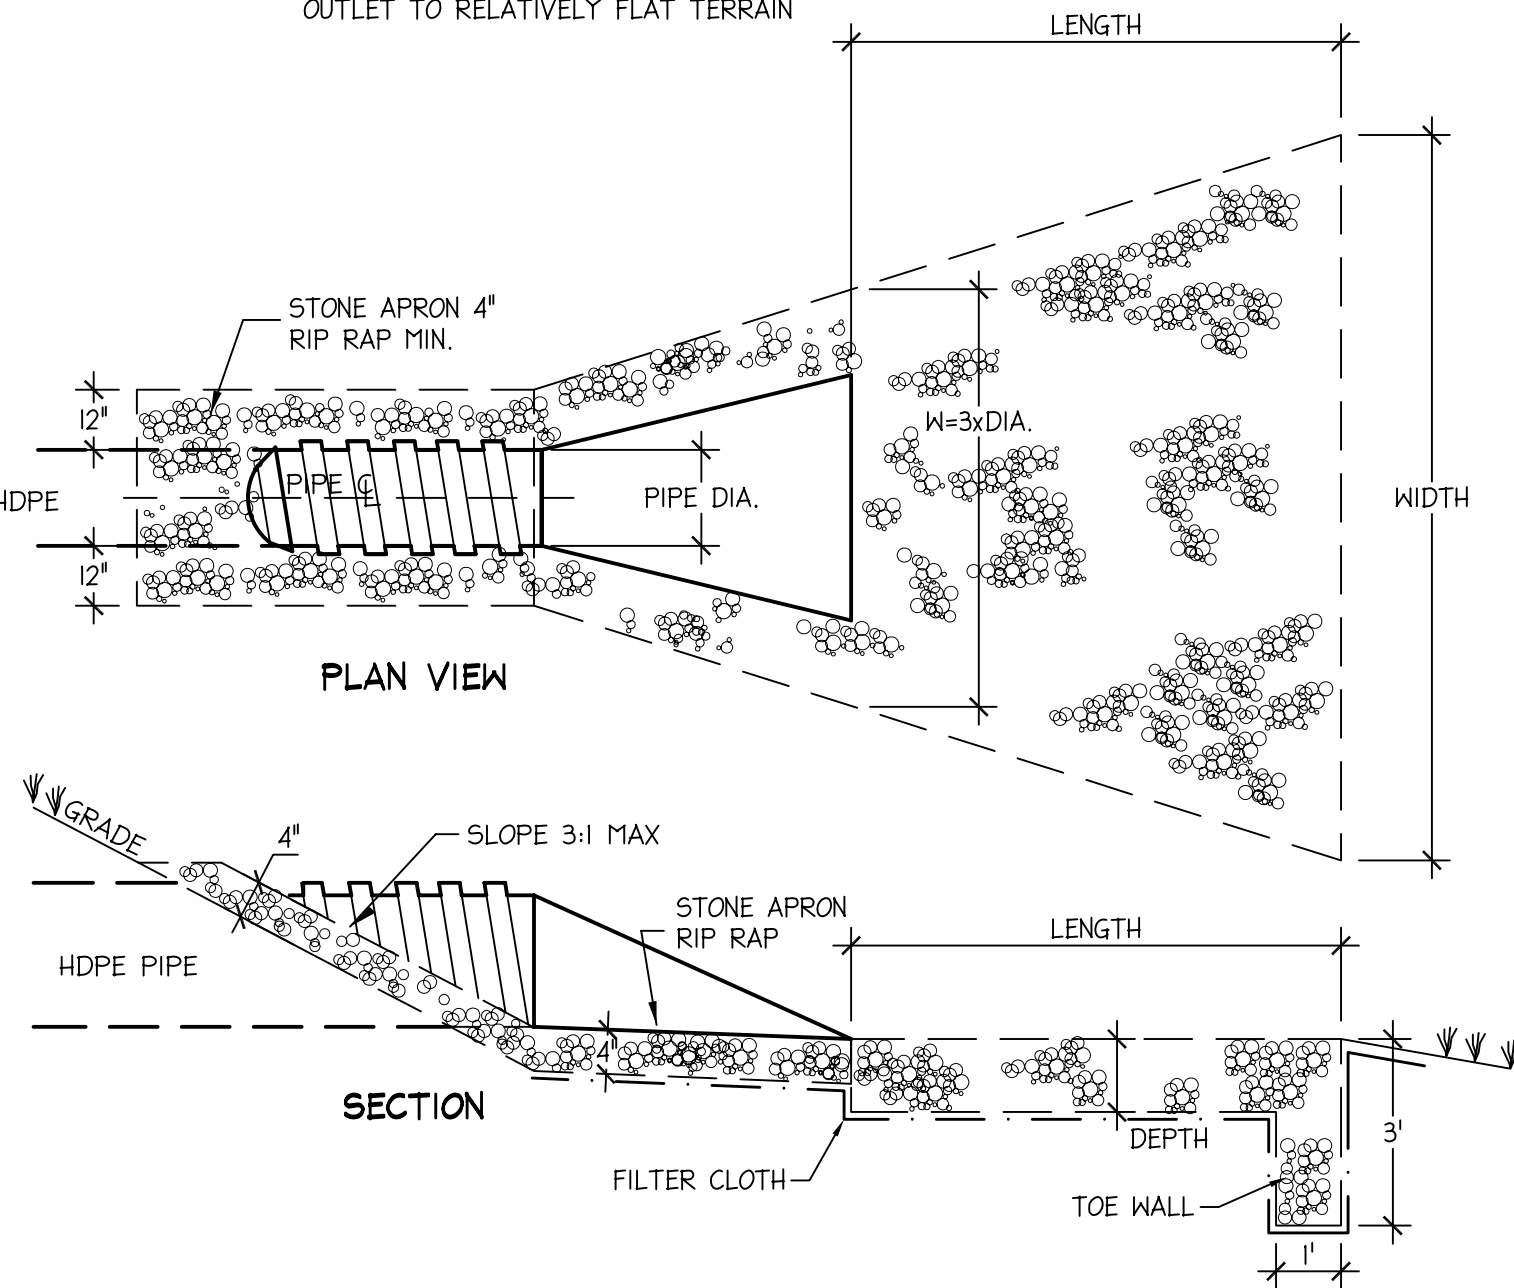


TYP. STONE APRON DETAIL  
N.T.S.

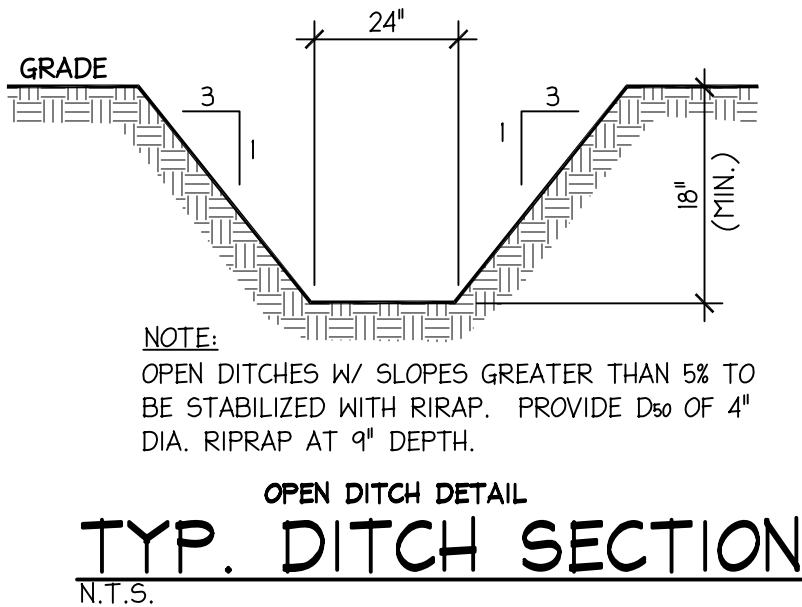

TYP. DITCH SECTION  
N.T.S.

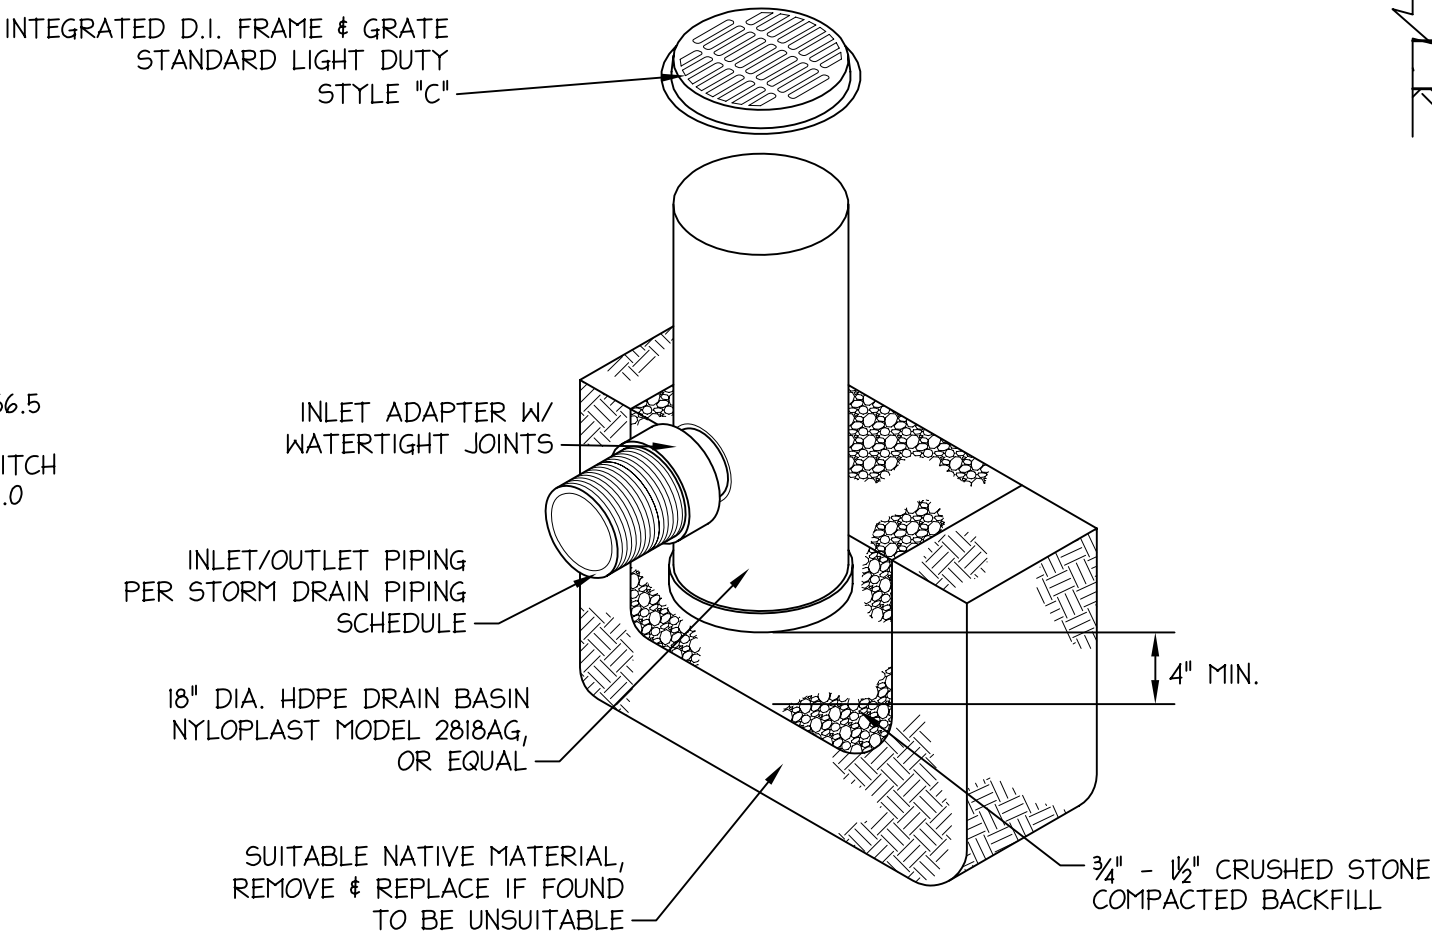

TYP. YARD DRAIN DETAIL  
N.T.S.

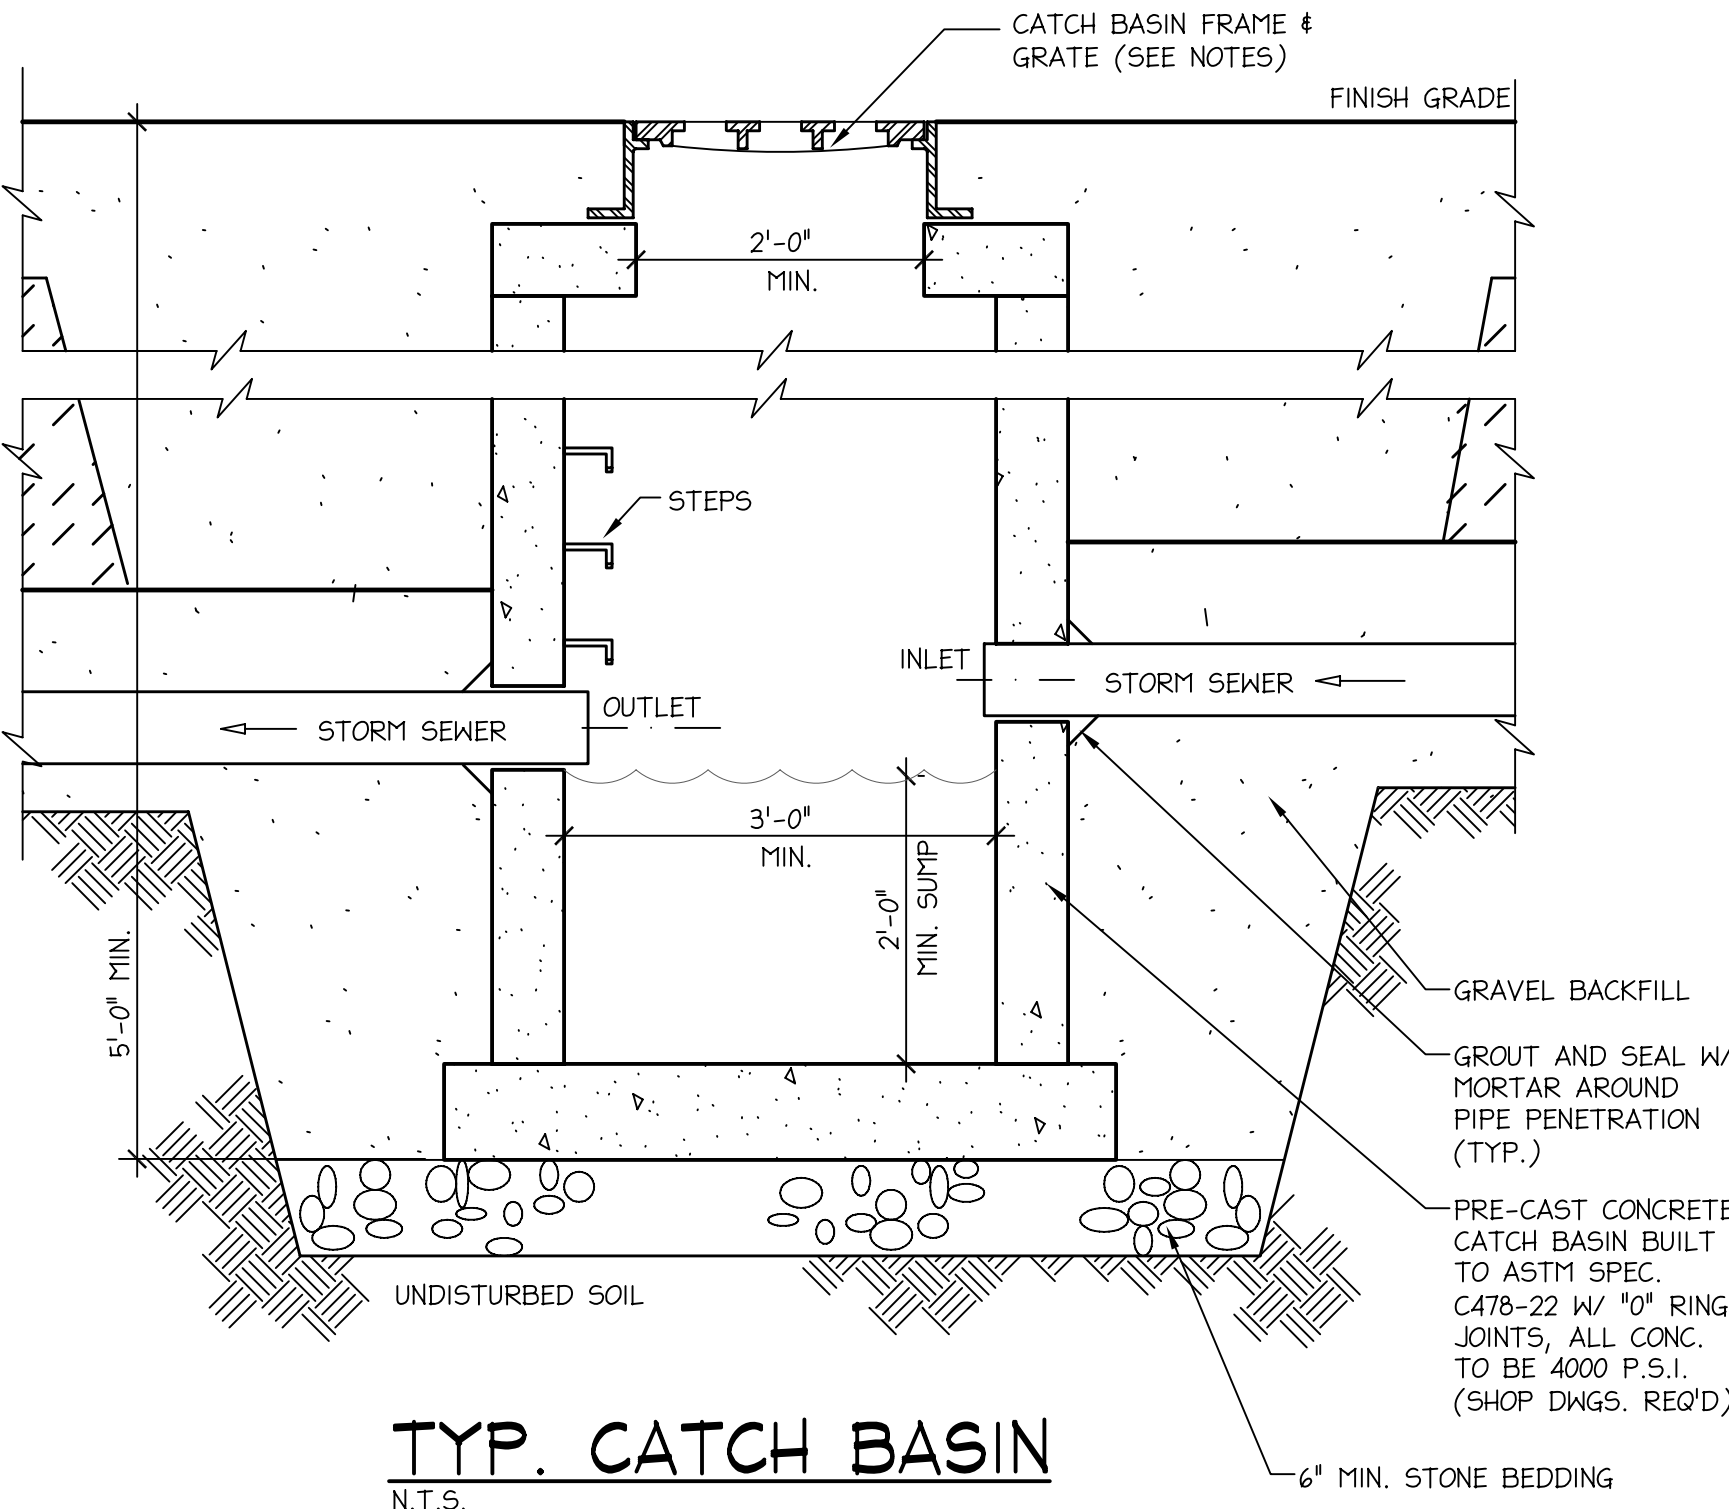

- NOTES:
- PROVIDE FRAME & GRATE SHOP DRAWINGS FOR OWNER/ENGINEER'S APPROVAL.
  - PROVIDE FRAME & GRATE STYLES AS INDICATED IN CATCH BASIN SCHEDULE, ALL MODELS BY SYRACUSE CASTINGS, OR EQUAL.  
STYLE 'A' - BEEHIVE STYLE GRATE #1255DC  
STYLE 'B' - ROUND OPEN GRATE #1186


CATCH BASIN SCHEDULE						
CATCH BASIN	RIM	ELEVATIONS			GRATE STYLE	
		INV. IN	INV. OUT	SUMP		
cbA	1355.60	-	1352.60	1350.60	"A"	
cbB	1355.60	1351.43	1351.43	1349.43	"A"	
cbC	1355.15	1350.90	1350.90	1348.90	"A"	
cbD	1354.84	1350.38	1350.38	1348.38	"A"	
cbE	1351.84	1348.34	1347.16	1345.16	"B"	
cbF	1352.40	1345.97	1345.97	1343.97	"B"	
cbG	1346.40	1342.40	1336.50	1334.50	"B"	
cbH	1354.00	-	1351.00	1349.00	"A"	
cbI	1354.00	1350.80	1350.80	1348.80	"A"	

YARD DRAIN SCHEDULE						
YARD DRAIN	RIM	ELEVATIONS			GRATE STYLE	
		INV. IN	INV. OUT	SUMP		
yd1	1352.00	1349.00	1349.00	1348.50	"C"	
yd2	1352.00	1348.00	1348.00	1347.50	"C"	
yd3	1352.80	-	1349.80	1349.30	"C"	
yd4	1352.80	1348.63	1348.63	1348.13	"C"	
yd5	1351.50	-	1348.50	1348.00	"C"	
yd6	1351.50	1346.50	1346.50	1346.00	"C"	

STORM DRAIN PIPING SCHEDULE						
PIPE RUN	CB TO CB	DIA.	LENGTH	INV. IN	INV. OUT	SLOPE
cbA	cbB	12"	117 LF	1352.60	1351.43	1.00%
cbB	cbC	12"	53 LF	1351.43	1350.90	1.00%
cbC	cbD	12"	52 LF	1350.90	1350.38	1.00%
cbD	cbE	12"	93 LF	1350.38	1348.34	2.19%
cbE	cbF	18"	119 LF	1347.16	1345.97	1.00%
cbF	cbG	18"	158 LF	1345.97	1342.40	2.26%
cbG	day/light	18"	27 LF	1336.50	1335.50	3.70%
cbH	cbI	12"	21 LF	1351.00	1350.80	0.95%
cbI	yd1	12"	76 LF	1350.80	1349.00	2.37%
yd1	yd2	12"	98 LF	1349.00	1348.00	1.02%
yd2	cbE	12"	84 LF	1348.00	1347.16	1.00%
yd3	yd4	12"	117 LF	1349.80	1348.63	1.00%
yd4	cbF	12"	108 LF	1348.63	1347.55	1.00%
yd5	yd6	12"	168 LF	1348.50	1346.50	1.19%
yd6	cbG	12"	74 LF	1346.50	1342.40	5.54%
dp outlet	12"	13 LF	1332.00	1330.60	10.8%	

NOTES:

- WHERE THE TRENCH BOTTOM IS UNSTABLE, EXCAVATE TO A DEPTH AS REQUIRED AND REPLACE WITH SUITABLE MATERIAL.
- SELECT BACKFILL SHALL BE NATIVE SOIL EXCAVATED FROM THE TRENCH, FREE OF ANY ROCKS WITH A DIMENSION OF 8 INCHES OR LARGER, WITH NO FOREIGN MATERIAL OR FROZEN EARTH.

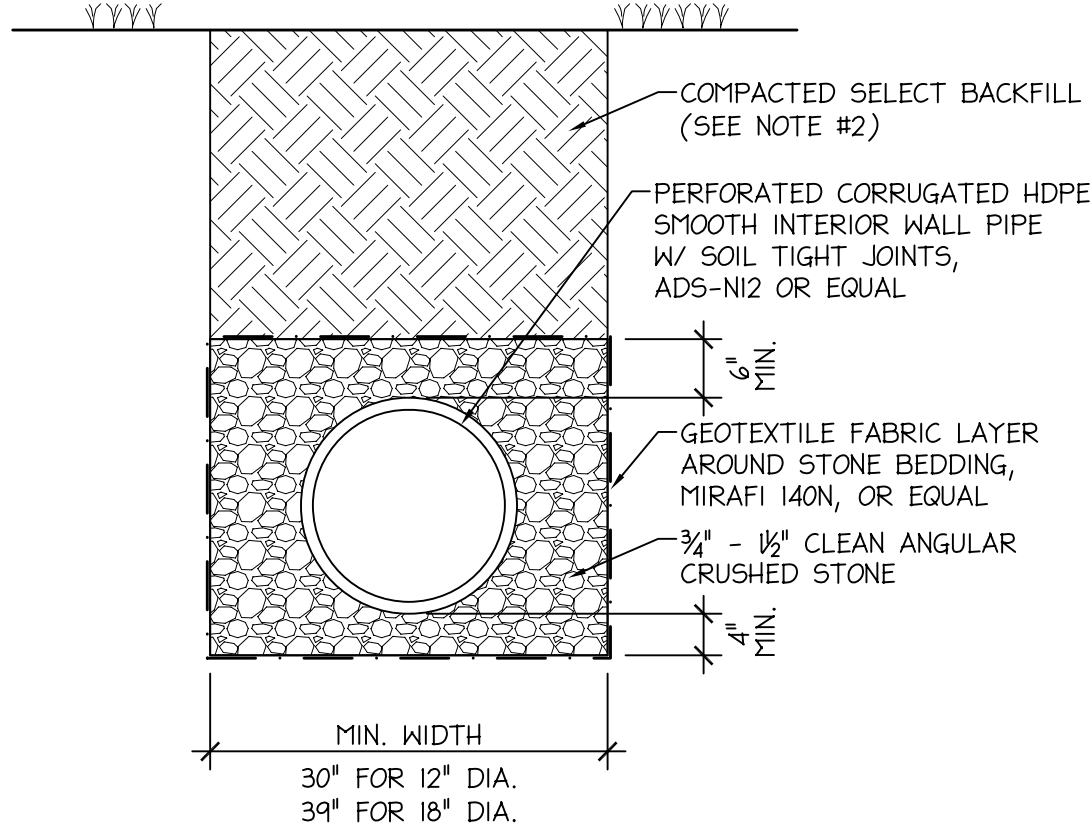

TYP. CULVERT SECTION  
N.T.S.

Established in 1985

AEDA

Architectural &  
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DESIGN  
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PROJECT TITLE  
**VILLAGE OF DANNEMORA  
LAFONTAINE PARK  
IMPROVEMENTS**  
BREENE LANE, VILLAGE OF DANNEMORA, CLINTON COUNTY, NEW YORK

ENGINEER STAMP

REVISIONS  
1 MSC 7/15/08

DRAWING TITLE  
**SITE DETAILS**

DRAWN BY MSC  
CHECKED BY JAA  
DATE 3/3/08  
PROJECT NO. 07106

**C2.1**

NYS OFFICE OF PARKS,  
RECREATION & HISTORIC  
PRESERVATION  
PROJECT # EPF-540530